

RETAINING WALL SEQUENCE:

- 1— SUBJECT TO NECESSARY AGREEMENTS WITH THE RELEVANT PARTIES, TEMPORARILY REMOVE THE TIMBER FENCE AND ERECT TEMPORARY HOARDING FOR THE AREA REQUIRED FOR EXCAVATION/BACKFILLING ETC.
- 2— CHECK EXISTING GROUND CONDITIONS AND LOCATE ANY UNDERGROUND EXISTING SERVICES THAT NEED PROTECTION PRIOR TO COMMENCEMENT OF ANY EXCAVATION WORKS.
- 3- ARRANGE THE NECESSARY SKIPS/SPOIL REMOVAL MEASURES TO THE FRONT OF THE PROPERTY.
- 4- REDUCE THE LEVELS BEHIND THE EXISTING WALL TO THE REQUIRED DEPTHS AND PROVIDE TEMPORARY SUPPORTS USING TRENCH SHEETING AND TIMBER STRUTTING TO THE RETAINED SOIL
- 5- DEMOLISH/REMOVE THE EXISTING RETAINING WALLS INCLUDING FOUNDATIONS IN SECTIONS
- 6— EXCAVATE IN SECTIONS TO THE FORMATION LEVEL WITH COMPACTED HARDCORE AND BLINDING READY TO CAST THE NEW RETAINING WALL SECTIONS.
- 7- INSTALL THE FORMWORK, INSTALL THE REINFORCEMENT CAGES AND CONNECTING DOWELS AND INCORPORATE DRAINS FOR WEEP HOLES.
- 8- POUR DESIGNATED CONCRETE AS PRESCRIBED. FOLLOW IN A 'HIT & MISS' SEQUENCE MARKED ON THE DRAWINGS WITH EACH SECTION NO LARGER THAN 1M.
 9- UPON COMPLETION OF THE WALL, INSTALL WATER DRAINS BEHIND THE WALL IN
- P-SHINGLES OR APPROPRIATE GRAVEL MATERIALS

 10-REMOVE THE TEMPORARY STRUTS/SHEETING FROM BEHIND AND BACK FILL
- TO THE DESIRED LEVEL.

11-REINSTATE THE TIMBER FENCING AND REMOVE TEMPORARY HOARDING.

REFER TO DWG No. SH19231/02 FOR RC DETAILS.

Revision Date Initial Status PRELIMINARY Elmgate Court, Hale Lane Edgware HA8 9RX Federick George Management Services Ltd Drawing Title Retaining Wall Date Drawn by Scale AS SHOWN AT A3 January 2020 N.K Project No Drawing No Revision 01 SH19231 LONDON OFFICE HITCHIN OFFICE 915 HIGH ROAD LONDON HITCHIN

Ph. 020 3488 2363

SURREY HILLS

info@surreyhillseng.co.uk


visit: www.surreyhillseng.co.uk

SG4 0AP

04.02.20

N.K

Issued for approval

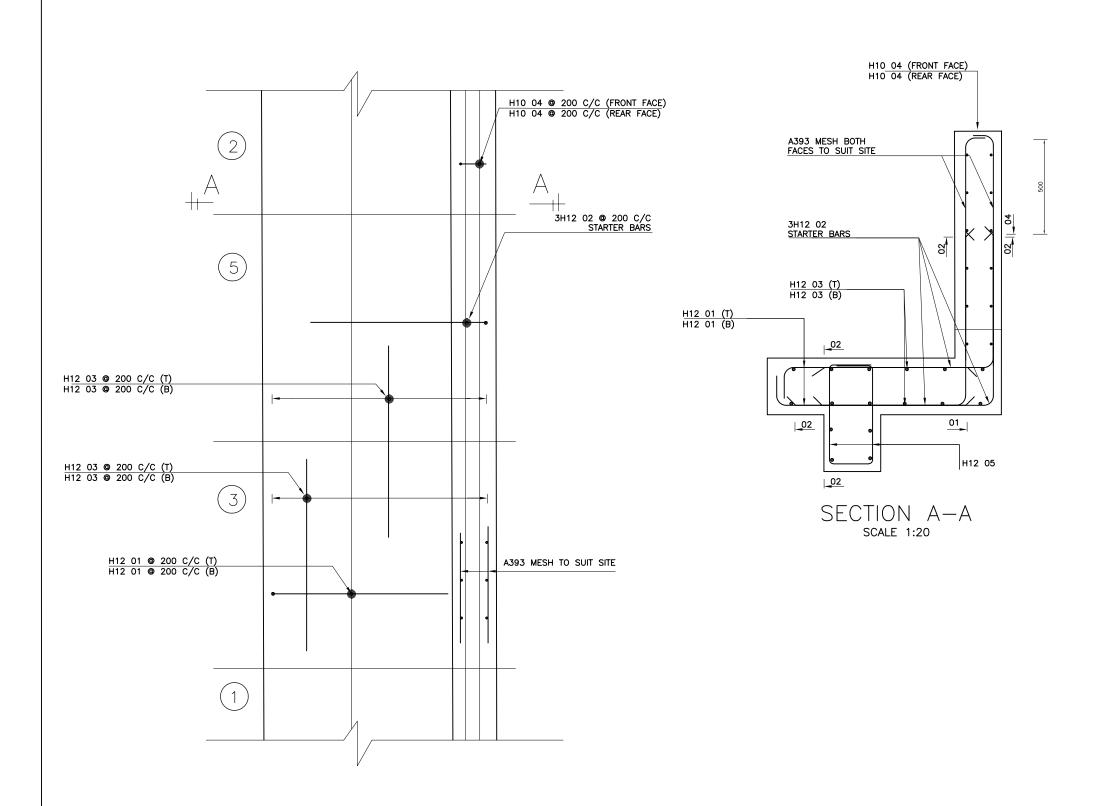

PART RETAINING WALL REINFORCEMENT PLAN SCALE 1:20

CONCRETE

- 1. ALL STRUCTURAL CONCRETE TO SUBSTRUCTURE/TO HAVE A 28 DAY CHARACTERISTIC STRENGTH OF 35N/MM2. MAX. AGGREGATE SIZE 20MM
- 2. CONCRETE TO BE MECHANICALLY VIBRATED.
- 3. THE USE OF PLASTICISERS SHOULD ONLY BE USED WITH THE WRITTEN PERMISSION OF THE ENGINEER.
- 4. LOOSE HIGH YIELD REINFORCEMENT SHALL COMPLY WITH BS 8666:2000.
- 5. MESH REINFORCEMENT SHALL COMPLY WITH BS8666.
- 6. MINIMUM LAP IN REINFORCEMENT TO BE 40 X DIAMETER
- 7. STEEL FABRIC TO BE LAPPED AS FOLLOWS: 450MM IN ALL DIRECTIONS.
- 8. CONTRACTOR TO PROVIDE CHAIRS TO SUPPORT
- 9. ALL EXCAVATIONS TO BE INSPECTED AND APPROVED BY THE ENGINEER/LOCAL AUTHORITY PRIOR TO CONCRETING.
- 10. BACKFILL MATERIAL TO COMPRISE OF SELECTED WELL GRADED APPROVED SUITABLE FILL. BACKFILL TO BE PLACED IN 125MM WELL COMPACTED LAYERS.
- 11. ALL MATERIALS USED ARE TO COMPLY WITH THE APPROPRIATE BRITISH STANDARD COVERING THEIR MANUFACTURE.
- 12. MINIMUM COVER TO REINFORCEMENT TO BE 50MM.

Issued for approval

04.02.20 N.K

Revision Date Initial Status

PRELIMINARY

Elmgate Court, Hale Lane Edgware HA8 9RX

Federick George Management Services Ltd

Drawing Title

Retaining Wall

Date Drawn by Scale AS SHOWN AT A3 N.K January 2020 Project No Drawing No Revision 02 SH19231



915 HIGH ROAD LONDON Ph. 020 3488 2363

visit: www.surreyhillseng.co.uk

LONDON OFFICE HITCHIN OFFICE HITCHIN HERTS SG4 0AP info@surreyhillseng.co.uk